


KEY MAP

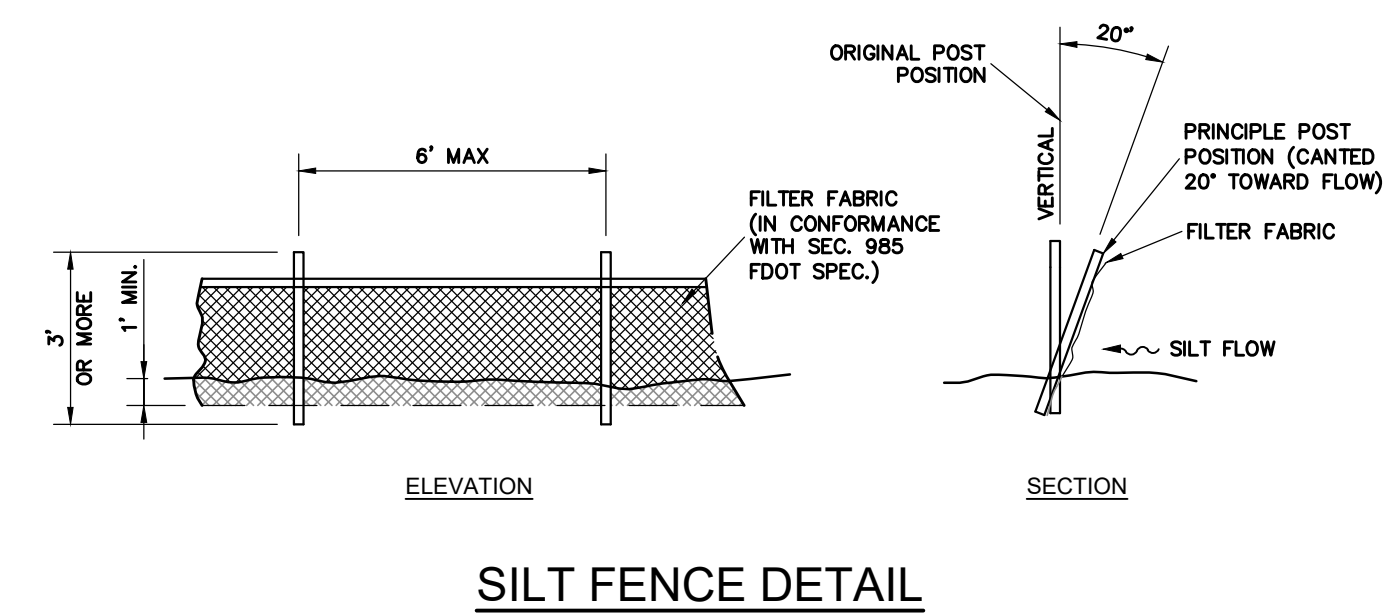


SILT FENCE DETAIL

LEGEND	
	OVERLAND FLOW
	PROPOSED GRADE

NOTES:  
1. THIS PLAN REFLECTS REQUIREMENTS APPLICABLE TO PROTECTING SURFACE WATER RESOURCES IN STORMWATER MANAGEMENT SITE PLANS OR SITE PERMITS APPROVED BY STATE, TRIBAL OR LOCAL OFFICIALS.  
2. SEDIMENT CONTROL MEASURES ARE TO BE MAINTAINED SO THAT SEDIMENT IS REMOVED FROM SEDIMENT BARRIERS WHEN THE DESIGN CAPACITY IS REDUCED BY 50%  
TOTAL SITE = 3.88 Ac.  
SITE AREA TO BE DISTURBED = 0.16 Ac.  
WETLAND AREA TO BE MITIGATED = 00.00 Ac.  
RUNOFF COEFFICIENT "C"  
BEFORE CONSTRUCTION = 0.90  
DURING CONSTRUCTION = 0.90  
AFTER CONSTRUCTION = 0.90

REVISIONS	
NO.	DESCRIPTION

DATE: JAN 2026  
SCALE: 1"=10'  
DESIGNED BY: C.R.L.  
DRAWN BY: A.V.  
JOB #: 25-4311

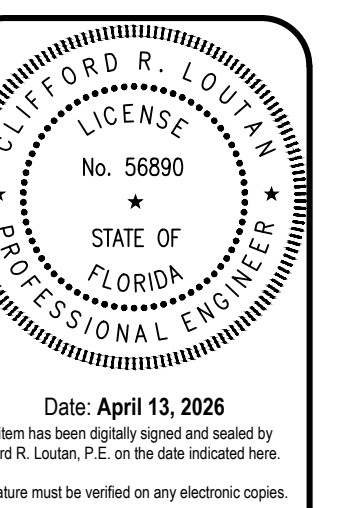

Date: April 13, 2026  
This item has been digitally signed and sealed by Clifford R. Lounsbury, P.E. on the date indicated here.  
Signature must be verified on any electronic copies.